

DEEMED PROPERTY LINE

Lakeshore Road

F.F.E. B1.25


WATERFRONT

ALL SEASON WATER

(=4105)

FEATURE

WATER "SALBOAT CLUB" POND/ ICE SKATING RINK

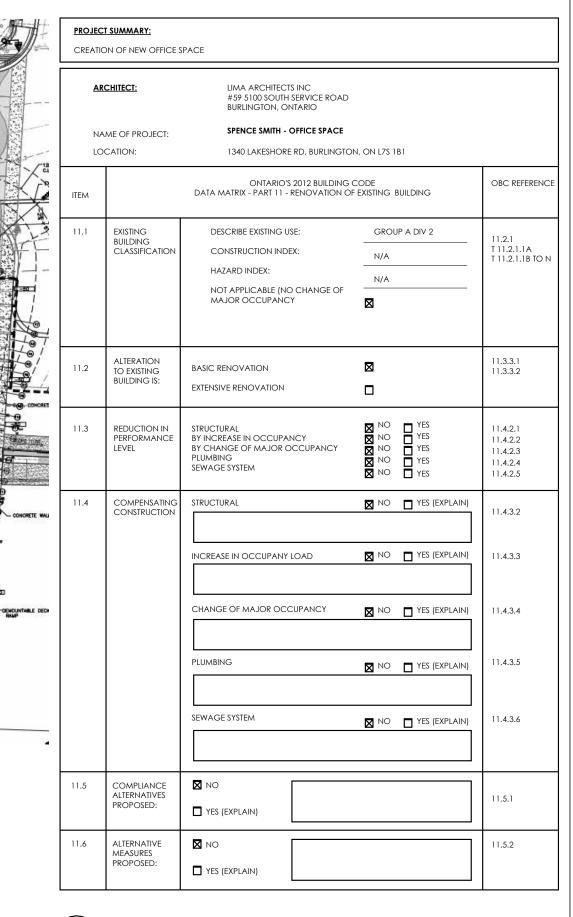

**OBC MATRIX - PART 11** 

A-0.1

N/A

ON I MACTOR IS TO CHECK AND VERIFY ALL DIMENSIONS NO CONDITIONS ON THE PROJECT AND REPORT ANY ISCREPANCIES TO THE ARCHITECT BEFORE PROCEEDING ITH THE WORK. DRAWINGS ARE NOT TO BE SCALED.

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SEALS

PROJECT TITLE

# SPENCER SMITH OFFICE SPACE

1340 Lakeshore Rd. Burlington, ON L7S 1B1

DRAWING TITLE

COVERSHEET & OBC NOTES

DRAWN BY

SCALE

DATE

JUNE 2023

RM

1:10

23-617


CHECKED BY

CHECKED BY

PROJECT NUMBER

DRAWING NUMBER

A-0.1

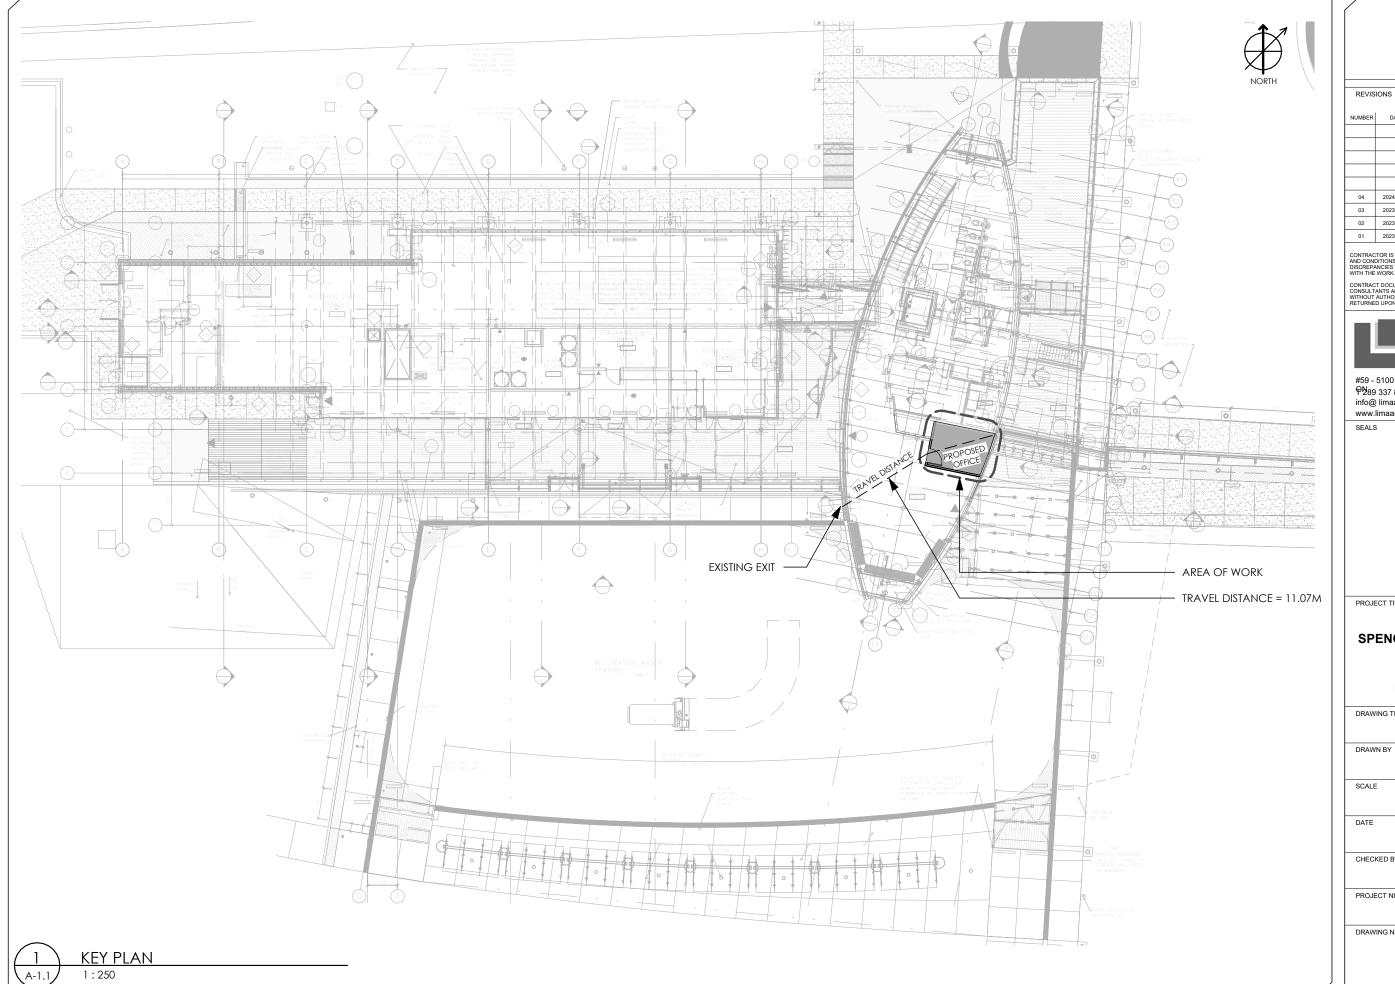

REVISIONS

04 2024 01 10 ISSUED FOR TENDER 03 2023 12 12 REVISED FOR BUILDING PERMIT 2023 10 11 ISSUED FOR BUILDING PERMIT 2023 06 26 ISSUED FOR CLIENT REVIEW



#59 - 5100 South Service Road Burlington P289 337 8887 info@ limaarchitectinc.com www.limaarchitectinc.com

SEALS

# **SPENCER SMITH OFFICE** SPACE

1340 Lakeshore Rd. Burlington, ON L7S 1B1

DRAWING TITLE

KEY PLAN

RM

1:250

23-617

JUNE 2023

SCALE

DATE

CHECKED BY

PROJECT NUMBER

DRAWING NUMBER

EXISTING WOOD

4.47 m

FEATURE WALL



1. REVIEW ALL EXISTING SITE CONDITIONS BEFORE COMMENCING THE WORK.

2. CARRY OUT ALL DEMOLITION WORK IN A SYSTEMATIC MANNER AS NECESSARY TO ACCOMMODATE CONSTRUCTION OF NEW WORK AS SHOWN ELSEWHERE IN THE CONSTRUCTION DOCUMENTS AND AS NOTED ON THIS

3. ALL WORK IS TO BE SUPERVISED BY AND EXPERIENCED FORMAN AT ALL TIMES.

4. ALL MATERIAL REQUIRED TO BE DEMOLISHED IS TO BE REMOVED FROM THE SITE AND DISPOSED OF AS PER THE REGULATIONS AND REQUIREMENTS OF ALL AUTHORITIES HAVING JURISDICTION.

5. AT THE END OF EACH DAYS WORK, LEAVE SITE IN AN SAFE CONDITION, SO THAT NO PARTS ARE IN DANGER OF COLLAPSE.

6. ENSURE THAT DUST IS MINIMIZED ON SITE AND IS CONTAINED THE DEMOLITION

### 7. RESERVED

THE DRAWINGS ARE NOT INTENDED TO PROVIDE A DETAILED SCOPE OF DEMOLITION ITEMS. THE CONTRACTOR SHALL DETERMINE THE EXACT EXTENT OF THIS WORK THROUGH CAREFUL SURVEY OF THE EXISTING CONDITIONS IN CONJUNCTION WITH THE CONTRACT DOCUMENTS, PRIOR TO THE CLOSE OF THE TENDER PERIOD, LATER CLAIMS FOR UNANTICIPATED EXTRAS WILL BE DISALLOWED.

8. EXISTING FIRE EXTINGUISHERS AND MOUNTS TO BE REMOVED WHEN REQUIRED FOR PAINTING. REINSTALL AFTER PAINTING IS COMPLETE.

9. MAKE GOOD AND REPAIR ALL AFFECTED AREAS TO MATCH THE EXISTING OR BETTER AS REQUIRED.

**NOTE:**NUMBER OF OCCUPANT LOAD IS NOT PROPOSED TO INCREASE WITH THE NEW OFFICE.

## **CONSTRUCTION NOTES:**

## TYP. INTERIOR WALL:

-13MM DRYWALL -92MM STEEL STUD (362\$125-PLAT25) @ 400MM O.C. -SOUND ATTENUATION BATT INSULATION -13MM DRYWALL

# **INTERIOR DOOR:**

965MM x 2100MM

# ALL CONSTRUCTION TO MEET LATEST **ONTARIO BUILDING CODE**

REVISIONS

NUMBER	DATE	REMARKS		
04	2024 01 10	ISSUED FOR TENDER		
03	2023 12 12	REVISED FOR BUILDING PERMIT		
02	2023 10 11	ISSUED FOR BUILDING PERMIT		
01	2023 06 26	ISSUED FOR CLIENT REVIEW		

SCREPANCIES TO THE ARCHITECT BEFORE PROCEE TH THE WORK. DRAWINGS ARE NOT TO BE SCALED.



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PROJECT TITLE

# **SPENCER SMITH OFFICE SPACE**

1340 Lakeshore Rd. Burlington, ON L7S 1B1

DRAWING TITLE

NEW OFFICE PLAN

RM

23-617

As indicated

DRAWN BY

SCALE

DATE

JUNE 2023


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PROJECT NUMBER

DRAWING NUMBER

2024-01-10 5:48:22 PM

GROUND FLOOR PLAN

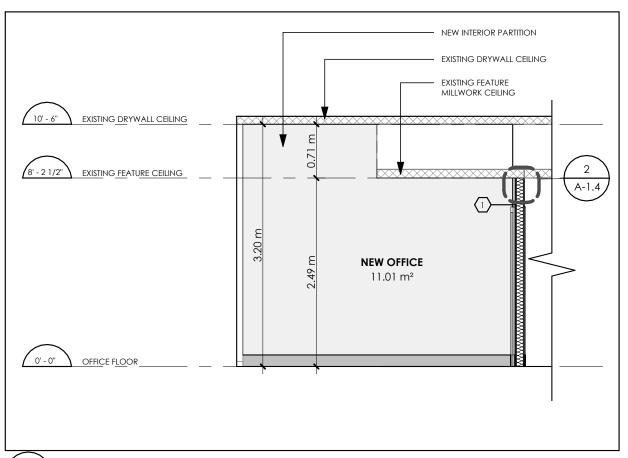

EXISTING CEILING

1" NAILER BOARD

CAULKING TYP

EXISTING FEATURE CEILING

WOOD BOARD
1/2 IN, X 4 IN, X 5 FI, HOBBY BOARD KILN
DRIED 54S POPLAR BOARD, PAINTED

1" STAINLESS STEEL REVEAL TYP


-13MM DRYWALL
-92MM STEEL STUD (33625 125-PLAT25) @ 400MM O.C.
-SOUND ATTENUATION BATT INSULATION
AS INDICATED
-13MM DRYWALL

1 BUILDING SECTION

1:50

N/A

5 TYP INTERIOR WALL AT EXISTING CEILING DETAIL

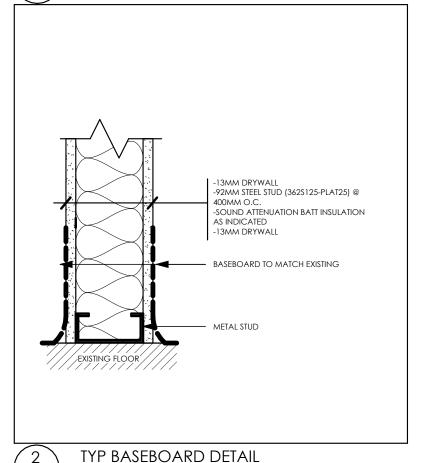

ALUMINUM CURTAIN
WALL MULLION

STEEL PLATE FASTENED
TO MULLION
SLIDING BTW. GYP.
BOARD

-13MM DRYWALL
-92MM STEEL STUD (362S125-PLAT25) @
400MM O.C.
-SOUND ATTENUATION BATT INSULATION
AS INDICATED
-13MM DRYWALL

METAL STUD

FLAT CASING ALL AROUND
1/2 IN. X 4 IN. X 3 FT. HOBBY BOARD KILN
DRIED S4S POPLAR BOARD. PAINTED

WOOD SHIM
DOOR LEAF

3 TYP INT WALL AT MULLION DETAIL
N/A

4 TYP DOOR WITH FLUS CASING DETAIL

NUMBER

REVISIONS

 NUMBER
 DATE
 REMARKS

 04
 2024 01 10
 ISSUED FOR TENDER

 03
 2023 12 12
 REVISED FOR BUILDING PERMIT

 02
 2023 10 11
 ISSUED FOR BUILDING PERMIT

 01
 2023 06 26
 ISSUED FOR CLIENT REVIEW

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SEALS

PROJECT TITLE

# SPENCER SMITH OFFICE SPACE

1340 Lakeshore Rd. Burlington, ON L7S 1B1

DRAWING TITLE

BUILDING SECTION & DETAILS

DRAWN BY

RM

As indicated

JUNE 2023

23-617

SCALE

DATE

CHECKED BY

PROJECT NUMBER

FROJECT NUMBER

DRAWING NUMBER

A-1/2



∞	CARBON MONOXIDE SENSOR				
60	NITROUS DIOXIDE SENSOR				
D	LOCKED THERMOSTAT W/ COVER				
Φ	THERMOSTAT				
0	HUMIDISTAT				
	LOCKED HUMIDISTAT W/ COVER				
<b>)</b> @(	CIRCULAR DIFFUSER				
×	DIRECTIONAL SQUARE DIFFUSER				
Ø	SQUARE DIFFUSER				
SIDEWALL LINEAR DIFFUSER					
=	LINEAR DIFFUSER				
<u> </u>	LINEAR RETURN AIR GRILLE				
<u>0</u>	12"x12" / 300x300 RETURN AIR GRILLE				
<u> </u> @	24"x12" / 600x300 RETURN AIR GRILLE				
<u></u>	24"x24" / 600x600 RETURN AIR GRILLE SUPPLY AIR DUCT UP/DN				
<del>-  </del>	RETURN/EXHAUST AIR DUCT UP/DN				
	RECTANGULAR DUCT W/ TAKE-OFF & BALANCING DAMPER				
	CIRCULAR DUCT W/ TAKE-OFF & BALANCING DAMPER				
	FLEX DUCT W/ TAKE-OFF & BALANCING DAMPER				
	CIRCULAR DUCT (DIAMETER)				
12x12	RECTANGULAR DUCT (MDTH x HEIGHT)				
	FLEX DUCT				
	SILENCER DUCT				
	INSULATED DUCT (WEATHER PROOFED)				
	FIRE WRAPPED DUCT				
	INTERNALLY LINED DUCT				
	OPEN ENDED DUCT				
<i>Œ</i> * <i>Œ</i> *	ONE WIDTH RADIUS DUCT ELBOW				
is i	MITERED ELBOW DUCT W/ TURNING VANES				
	RECTANGULAR DUCT CONCENTRIC TRANSITION				
	RECTANGULAR DUCT ECCENTRIC TRANSITION				
ш	RECTANGULAR DUCT ELEVATION TRANSITION				
	CIRCULAR DUCT CONCENTRIC TRANSITION				
	CIRCULAR DUCT ECCENTRIC TRANSITION				
	CIRCULAR TO RECTANGULAR DUCT TRANSITION				
	DUCTS ABOVE CROSSING DUCTS				
	DUCTS BELOW CROSSING OTHER DUCTS				
<b>=</b>	ACOUSTICALLY LINED TRANSFER AIR DUCT W/ GRILLE				
	ACOUSTICALLY LINED TRANSFER AIR DUCT				
	SIDE WALL SUPPLY AIR GRILLE				
0	CEILING MOUNTED RETURN AIR GRILLE				
0	CEILING MOUNTED SUPPLY AIR GRILLE				
L W	# = NUMBER OF TYPICAL GRILLES L = LENGTH OF GRILLE W = WIDTH OF GRILLE FLOW = AIR FLOW AMOUNT				
Ø T FLOW	# = NUMBER OF TYPICAL DIFFUSER  # = NECK CONNECTION SIZE/FLEX DUCT SIZE  T = TYPE OF DIFFUSER  FLOW = AIR FLOW AMOUNT				
EQ #	EQ # = EQUIPMENT # FLOW = AIR FLOW OUT/IN				
u/c	DOOR UNDERCUT				
	BALANCING DAMPER				
	FIRE DAMPER				
FD FD	MOTORIZED DAMPER				
க்க்	FLOOR FIRE DAMPER SUPPLY / RETURN DUCT				
	WALL MOUNTED FORCE FLOW HEATER				
(0000)	CEILING MOUNTED FORCE FLOW HEATER				
	BASEBOARD HEATER 1m/3.2ft PER 1KW				
	VERTICAL/PACKAGED TERMINAL AIR CONDITIONING UNIT				
₩	UNIT #				
ABG	AUTOMATIC BALANCING GRILLE				
RAT	REVERSE ACTING THERMOSTAT				
C02	CARBON DIOXIDE SENSOR				

SCALE:

AS SHOWN


DRAWN/CHECKED BY:

DL / MN

DRAWING NO.

D-M201

CONSULTANT	REVISIONS			DRAWNG:	STAMP OF ESSIONAL	PROJECT:	
	ND	REMARKS	DATE		Dan Cr.		
	01	ISSUED FOR COORDINATION	AUG. 18/23	GROUND FLOOR - HVAC DEMOLITION	D. JAIN		WATERFONT CENTRE
	02	ISSUED FOR PERMIT	OCT. 10/23		MAR 03,23)		BURLINGTON SPENCER OFFICE
7405 East Danbro Crescent,					23-207		SPENCER OFFICE
Mississauga, Ontario, L5N 6P8 Canada				LOUROS DESIGN	PROJECT NO:		
Tel: +1 416 728-0906				35 TEFLEY ROAD,TORONTO M2M 1C3 Tel. (416) 399-2886	23-207		
www.jainconsultants.com				Tel. (416) 399−2886 andrew⊕lourosdesign.ca			

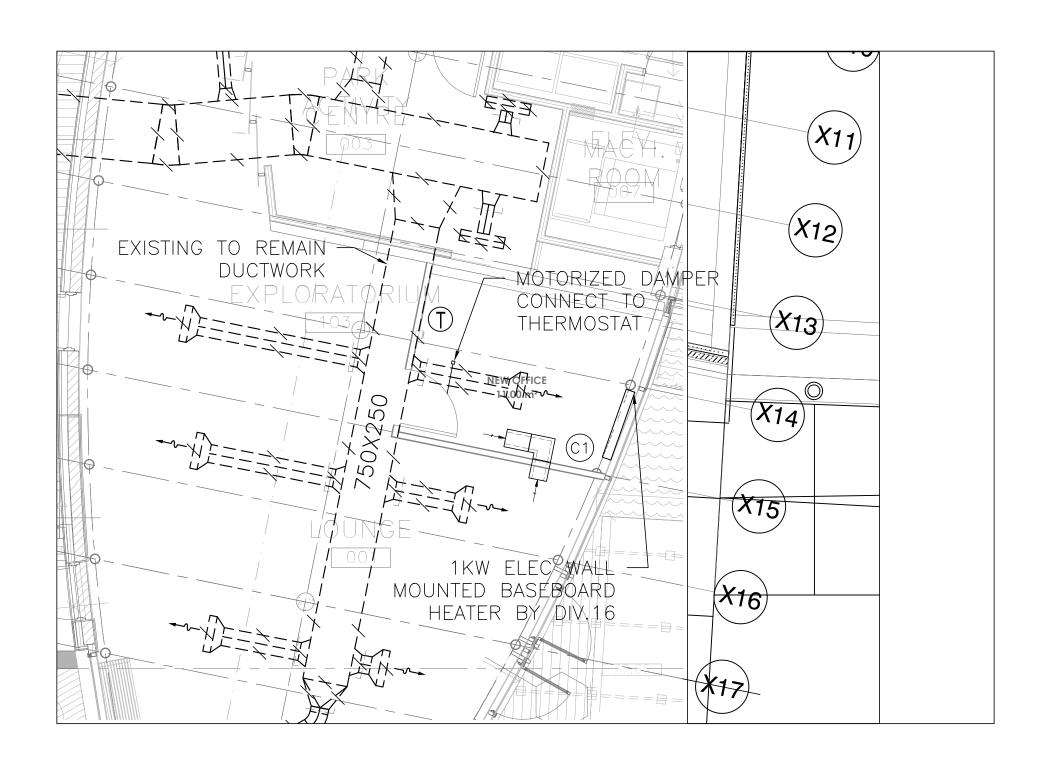

CONSULTANT REVISIONS			DRAWING:	STAMP OROFESS/ONAL	PROJECT:	DATE:	
7405 East Danbro Crescent,	NΠ	REMARKS	DATE	PROPOSED GROUND FLOOR - HVAC	STAMP  ROTESSIONAL  D. JAIN  MAR 03.23  23-207	WATERFONT CENTRE BURLINGTON	2023/03/03
	01	ISSUED FOR COORDINATION	AUG. 18/23				SCALE: AS SHOWN
	02	ISSUED FOR PERMIT	OCT. 10/23				DRAWN/CHECKED BY:
							DL / MN
Mississauga, Ontario, L5N 6P8 Canada				LOUROS DESIGN 35 TEFLEY ROAD,TORONTO M2M 1C3	PROJECT NO:		DRAWING NO.
Tel: +1 416 728-0906 www.jainconsultants.com				Tel. (416) 399–2886 andrew@lourosdesign.ca	23-207		M201

### **ELECTRICAL SPECIFICATIONS**

- A. THE ELECTRICAL CONTRACTOR SHALL FURNISH ALL LABOUR, MATERIAL, TOOLS, EQUIPMENT, ETC.
  REQUIRED TO COMPLETE ALL WORK SHOWN ON THE DRAWINGS AND HEREIN SPECIFIED. THE WORK SHALL BE
  IN ACCORDANCE WITH RILLES AND RESOLUTIONS OF ALL AUTHORITIES HAVING LEGAL JURISDICTION OVER THE
  WORK THIS CONTRACTOR SHALL PROMISE ANY SMALL ITEMS OF WORK NOT SPECIFICALLY CALLED FOR BUT
  REQUIRED TO COMPLETE THE INTENDED INSTALLATION.
- B. THE ENGINEER RESERVES THE RIGHT TO APPROVE THE QUALITY OF MATERIAL AND WORKMANSHIP, ALSO TO CALL OF FOR ANY TESTS WHICH ARE DEBUED RECESSAND THE PROGRESS OF THE WORK AND A COMPLETE TEST DEBUG STEED AT THE COMPLETION OF THE WORK. THE COST OF SUCH TESTS ARE NOT TO BE CONSIDERED AS

#### 2. SCOPE OF WORK

THE WORK SHALL CONSIST OF, BUT SHALL NOT BE LIMITED TO THE FOLLOWING:

- A. ALL NECESSARY CONDUIT WIRING AND CONNECTIONS FOR A COMPLETE INSTALLATION.
- B. LIGHTING AND POWER DISTRIBUTION SYSTEM AS SHOWN ON THE DRAWINGS.
- C. MOTOR CIRCUITS.
- D. COMPLETE CONDUIT SYSTEM FOR LOW VOLTAGE SYSTEM WHERE NOTED ON THE DRAWINGS

#### CODES, PERMITS AND INSPECTION

- A. This contractor shall be responsible for and shall detain all permits, inspections, etc. As reduired by all authorities having jurisdiction over this work and shall pay for same. These costs shall be included in the tender price.
- B. ALL PERMITS SHALL BE DELIVERED TO THE OWNER REPRESENTATIVE AS SOON AS THEY BECOME AVAILABLE.

THIS CONTRACTOR SHALL PREPARE, AT HIS OWN EXPENSE, ANY LARGE SCALE WORKING DRAWINGS WHICH MAY BE REQUIRED BY THE EXAMINING AUTHORITIES.

#### 5. AS-BUILT DRAWINGS

THIS CONTRACTOR SHALL KEEP A SEPARATE SET OF WHITE PRINTS ON THE SITE AND NOTE ALL CHANGES AND DEVATIONS FROM THE ORIGINAL DESIGN. TWO SETS OF THESE PLANS ALONG WITH UPDATED ACAD 2000 DRAWNINGS SHOULD BE FORWARDED TO THE ENGINEER AT THE COMPLETION OF THIS CONTRACT BEFORE APPLYING FOR FINAL PAYMENT.

SUBMIT TO ENGINEERS THE FOLLOWING DOCUMENTS FOR REVIEW AND APPROVAL AT THE COMPLETION OF PROJECT:

- ESA INSPECTION CERTIFICATE
- SHOP DRAWINGS

Submit SIX (6) copies of manufacturer's shop drawings for all devices, systems and such for review by the engineer.

### EXAMINATION OF SITE

- A THIS CONTRACTOR SHALL VISIT THE SITE OF THE PROJECT AND FAMILIARIZE HIMSELF WITH THE SPECIFIC SITE CONDITIONS.
- B. ANY DEVATION AND / OR CONFLICTS ON SITE ESPECIALLY CONCERNING THE DISTRIBUTION DIAGRAM (S) AS SHOWN ON THE PLANS, SHALL BE REPORTED TO THE ENGINEER PRIOR TO SUBMITTING TENDER.

THIS CONTRACTOR SHALL SCHEDULE AND PERFORM HIS WORK TO MEET THE COMPLETION SCHEDULE AS SET OUT BY THE PLANNING HOUSE.

#### REVISIONS AND EXTRAS

NO ADDITIONAL MONEY OVER THE CONTRACT PRICE SHALL BE PAID UNLESS AN APPROVED CHANGE ORDER IS ISSUED BY THE ENGINEER. CLAMS FOR EXTRAS SHALL BE SUBMITTED WITH A COMPLETE BREAKDOWN OF MATERIAL, LABOUR, HOUTRY RATES, ETC.

THERE SHALL BE NO EXTRA CLAIM FOR RELOCATION OF ANY EQUIPMENT WITHIN 10 FEET FROM ORIGINAL LOCATION

### 10. CLEAN UP

THIS CONTRACTOR SHALL BE RESPONSIBLE TO PERIODICALLY REMOVE ALL DEBRIS AND TO KEEP THIS AREA CLEAN AT ALL TIMES.

### 11. CUTTING AND PATCHING

ELECTRICAL CONTRACTOR SHALL BE RESPONSIBLE FOR ALL CUITING AND PATCHING, OPENINGS, ETC. AND SHALL REFORM THE GENERAL CONTRACTOR OF SLEEVES OR OPENINGS REQUIRED DURING FEDDERING SO THAT COSTS ARE ROLLUDED AND SHALL RIFORM THE GENERAL CONTRACTOR IN SUFFICIENT TIME TO PREVENT UNDESSESSIFY CUTTING.

### 12. CONDUIT IN SLAB

THIS CONTRACTOR SHALL NOT INSTALL RIGID CONDUIT AND FLOOR BOXES IN STRUCTURE FLOOR SLABS OR FRAMING OR CLIT STRUCTURE, SLABS AND FRAMING FOR THE SUPPOSE IN SICH A MANNER THAT THE STRUCTURAL MIREGRATY OF THE FLOOR IS MEACHED. COORDINATE SLOCH WORK WITH THE ACCURITED OR STRUCTURAL BEGIN

THIS CONTRACTOR SHALL PLACE AN ORDER FOR ALL MATERIAL AND EQUIPMENT IMMEDIATELY AFTER SIGNING OF THE CONTRACT. HE SHALL SUBMIT A LIST OF DELIVERY DATES FOR EACH TYPE OF EQUIPMENT WITHIN 30 DAYS OF THE AWARDING OF THE CONTRACT. THE LIST SHALL INCLUDE MANUFACTURER'S NAMES.

### 14. EQUIPMENT AND MATERIAL

Grounding shall be as required by electrical code and the approval of all equipment and material unless specifically noted otherwise, shall be now and without bleuish or defect. All material, and equipment shall be of the type subject to factory mutual, "undernithers laboratories of campa" or "campa" or "ca

### 15. DEMONSTRATION OF THE SYSTEM

DEMONSTRATE THE FUNCTION AND OPERATION OF EACH SYSTEM IN MAINTENANCE STAFF OWNER AND CONSULTANT PRESENCE, CO-ORDINATE COMMISSIONING AND TRAINING SCHEDULE WITH ALL PARTIES.

### 16. IDENTIFICATION

PROVIDE LAMACOID IDENTIFICATION INMEPLATES. THESE SHALL BE BLACK WITH WHITE ENGRAVED LETTERS AND SHALL BE INSTALLED WITH SCREWS ON ALL EQUIPMENT, DISCONNECT SWITCHES, PANELS, ETC. INDICATING THE LOAD SERVED. EACH LIGHTING PANEL SHALL HAVE A TYPEWRITTEN DIRECTORY SHOWING LIGHTS OR EQUIPMENT A CONNECTED TO EACH CIRCLIT. DIRECTORIES SHALL BE MORTED ON THE MISSIO OF THE PANEL DOOR WITH A TRANSPARENT PLASTIC COVER, RECEPTACLES AND LIGHT SWITCHES SHALL BE LABELLED WITH CIRCUIT MUMBER B STOYL-OM ADDRIVED THE LABEL HAVE

### **ELECTRICAL SPECIFICATIONS (CONTD.)**

THIS CONTRACTOR SHALL BE RESPONSIBLE TO CO-ORDINATE THE INSTALLATION OF EQUIPMENT, CONDUIT WORK, LIGHTING FIXTURES, ETC. WITH OTHER TRADES PRIOR TO THE ACTUAL INSTALLATION.

ALL WORK SHALL BE INSTALLED SO AS TO BE READILY ACCESSIBLE FOR OPERATION, MAINTENANCE AND REPAIRS.

THIS TRADE SHALL BE RESPONSIBLE FOR THIS WORK UNTIL THE COMPLETION AND FINAL ACCEPTANCE, FOR REPLICIOR ANY TIES HATM MAY BE DEFECTIVE, DAMAGED, LOST OR STOLEN WITHOUT ADDITIONAL COST TO THE OWNER OR DELAY TO THE COMPLETION OF THE PROJECT.

THIS CONTRACTOR SHALL WARRANT ALL WORK AND EQUIPMENT INSTALLED UNDER THIS CONTRACT, AGAINST ALL DEFECTS OR WORKMANSHP AND INJECTION. FOR A PERIOD OF ONE YEAR AFTER ACCEPTANCE OF THE INSTALLATION BY THE OWNER.

#### 21. CONDUIT AND FITTINGS

- A. CONDUIT SIZES SHALL BE AS INDICATED ON THE DRAWINGS AND SHALL NOT BE REDUCED IN SIZE WITHOUT AUTHORIZATION. CONDUIT IN TRINSHED AREA SHALL BE CONCEALED. ALL CONDUIT SHALL BE WITHAUED PARALLET TO BUILDING LINES. MAYE FIRM, CONNECTIONS TO WIREATING EQUIPMENT WITH FIEURIEE CONDUIT.
- B. CONDUITS SHALL BE INSTALLED AT A MINIMUM OF 6" (152MM) FROM UNINSULATED HEATING PIPES.
- C. CLEAN INTERIOR OF ALL CONDUITS TO REMOVE WATER AND DEBRIS BEFORE PULLING WIRES.
- D. BX CABLES SHALL BE USED FOR FINAL SHORT CONNECTIONS BETWEEN OUTLET AND OUTLET BOX IN CELLING SPACE TO CELLING MOUNTED LIGHTING FIXTURES OR TO FEED OUTLETS, RECEIPTACLES IN THE DRYMALL PARTITIONS, BY CABLES ARE NOT ALLOWED TO RUN IN THE OPEN CELLING AREAS.
- E. EMPTY FLEXIBLE STEEL CONDUIT 1/2" (13MM) MINIMUM DIAMETER AND A MAXIMUM OF 6 FEET (1830MM) OR (1.83M) LONG, WITH A FISH WIRE AS INDICATED IN THE DRAWINGS CAN ALSO BE USED.
- F. FOR FIREPROOFING WHERE HOLES ARE DRILLED THROUGH FLOORS OR WALLS. THEY SHALL BE PACKED AROUND CONDUIT WITH "34" BRAND FIRE BARRIER CAULK FB369 COMPOUND. MINMAUM CONDUIT SHALL BE 3/4"
  (19MM), UNLESS OTHERWISE NOTED.
  G. CONDUITS AND ARMORED CABLES SHALL BE SUPPORTED INDEPENDENTLY OF THE SUSPENDED CELLING.
- H. SUPPLY AND INSTALL CONDUIT FOR WIRING AND CABLES WHERE THERE IS NO SUSPENDED CEILING SPACE.

- A. BOXES SHALL BE CODE GAUGE AND SIZES TO MEET THE ELECTRICAL CODE REQUIREMENTS. SHEET STEEL BOXES FOR CONCEALED WORK AND CAST BOXES FOR EXPOSED WORK.
- B. PROVIDE BARRIERS IN BOXES WHERE DIFFERENT VOLTAGES ARE USED.
- C. PROVIDE PULL BOXES ON CONDUIT AT 50-FOOT (15.25M) INTERVALS.
- D. BOXES SHALL BE SUPPORTED INDEPENDENTLY OF CONDUIT.

#### 23. INSTALLATION OF OUTLETS

THE PLANS SHOW APPROXIMATE LOCATION OF OUTLETS, EXACT LOCATION SHALL BE CO-ORDINATED ON THE SITE WITH OTHER TRADES, ARCHITECTURAL PLANS, ETC. CUTLETS INACCURATELY LOCATED SHALL BE RE-ADJUSTED OR RELOCATED AT THE CONTRACTOR'S EXPENSE. UNLESS OTHERWISE NOTED ON THE PLAN (S), LOCATE OUTLETS AS FOLLOWS:

- A. RECEPTACLES, TELEPHONE OUTLETS 18" ABOVE FINISHED FLOOR.
- B. OUTLETS OVER COUNTER, 42" ABOVE FLOOR OR CO-ORDINATE ON JOB.
  C. OUTLETS IN MECHANICAL, ELECTRICAL AND TELEPHONE ROOMS 47" (1200MM) ABOVE FLOOR.
- D. LIGHT SWITCHES 47° TO TOP FROM FINISHED FLOOR.

- A. UNLESS OTHERWISE NOTED, ALL WIRES SHALL BE COPPER R90, RW90, R490 OR RWU90 RATING AS REQUIRED ON SITE AND AS DICTATED BY CODE. ALUMINUM WIRE SHALL NOT BE USED.
- B. THE MINIMUM PERMISSIBLE SIZE FOR BRANCH CIRCUIT WIRING SHALL BE \$12 (20m). EXCEPT FOR EMERGENCY
- C. FOR BRANCH WIRING EXCEEDING 100 FEET (30.5M) TO FURTHEST OUTLET FROM A PANEL SHALL BE \$10 AT 120 VOLTS.
- D. WIRES AND CABLES SHALL BE RATED AT 600 VOLTS EXCEPT FOR LOW VOLTAGE CONTROL WIRING WHICH SHALL BE RATED AT 300V.
- E. ALL WIRES SHALL BE NEW AND DELIVERED TO THE SITE OF THE PROJECT IN THEIR ORIGINAL PLACKING. WIRES \$10 AND BIGGER SHALL BE STRANDED. THIS DEDITES GAUGE \$6, \$6, \$4, ETC. WIRES SHALL BE FACTORY DETITIES, SHOWNED SEX, VOLTAGE RATING AND INSULATION TYPE.
- F. PROVIDE SEPARATE INSULATED GROUND CONDUCTOR FOR EACH FEEDER AND BRANCH CIRCUIT.
- G. FINAL COMPECTIONS TO LUMINUMPES SMALL ORIGINATE FROM AN OUTLET BOX. COMPECTIONS OF FIXTURE BODY TO FIXTURE BODY SHALL NOT BE ACCEPTIBLE.
- H. CODE APPROVED WIRE SHALL BE USED FOR FINAL LUMINAIRE OR APPLIANCE CONNECTIONS.

# PROMDE AN APPROVED TYPE WIRE CONNECTOR SIMILAR TO "IDEAL" OR "SUPER-NUT".

### 26. WIRING DEVICES

- A. DUPLEX RECEPTACLES SHALL BE GROUNDING TYPE MINIMUM RATED FOR 15A. 120Y, SPECIFICATION GRADE AND TOGGLE TYPE UNLESS OTHERWISE SPECIFIED ON PLANS, THESE SHALL HAVE BREAK-OFF LINE TO ALLOW FOR SPLIT WIRRING OR 2 CIRCUITS. EQUIVALENT MANUFACTURER OF RECEPTACLES ARE AS FOLLOWS: "ARROW HART" AND "PASS & SEYMOLT, SPECIFICATION GRADE, GREATER, PURPOSE RECEPTACLES ALL BE WHITE AND RECEPTACLES DEDICATED FOR ELECTRONIC EQUIPMENT SUCH AS COMPUTERS, COPIER ETC. SHALL BE WHITE IN
- B. LIGHT SWITCHES SINGLE POLE/3—WAY AND 4—WAY AS SHOWN SHALL BE "WHITE" AND SPECIFICATION GRADE EQUAL TO HUBBELL 1200 SEWES. EQUINALENT MANUFACURER OF SWITCHES ARE AS FOLLOWS: "ARROW HART" AND "PASS & SEYMOUR", SPECIFICATION GRADE.
- C. COVER-PLATES SHALL BE STAINLESS STEEL.

### **LEGEND**

- 15A 120V 1P DUPLEX RECEPTACLE.
- DUPLEX RECEPTACLE MOUNTED ABOVE COUNTER.
- G.F.I DUPLEX RECEPTACLE
- G.F.I DUPLEX RECEPTACLE MOUNTED ABOVE COUNTER

A' DENOTES RECEPTACLE TO BE FED FROM AFCI (ARC FAULT CIRCUIT INTERRUPTER) TYPE

- 250V, 3-POLE, 50A RECEPTACLE 14-50R FOR RANGE
- 250V, 3-POLE, 30A RECEPTACLE 14-30R FOR DRYER/WALL OVEN
- 250V, 3-POLE, 20A RECEPTACLE 14-20R FOR MICROWAVE OVEN, UPS RACK ETC.
- 250V, 3-POLE, 20A,2P (6-20R) RECEPTACLE FOR PTAC UNITS,

#### PANELBOARD

V

0 DISCONNECT SWITCH - WP DENOTES WEATHERPROOF

DATA/TEL OUTLET (SINGLE GANG BACKBOX). REFER DWG. E801 FOR ROUGH—IN REQUIREMENTS.

- DENOTES RANGE DENOTES RANGE HOOD
- DENOTES DISHWASHER DENOTES MICROWAVE
- DENOTES FRIDGE DENOTES EXISTING TO REMAIN
- DENOTES EXISTING TO BE REMOVED
- DENOTES EXISTING TO BE RELOCATED
- DENOTES EXISTING IN RELOCATED POSITION (RECONNECT AS PREVIOUS/NOTED)

RE/RE DENOTES EXISTING REMOVED AND REINSTALLED IN PREVIOUS POSITION


### **GENERAL NOTES:**

- DIVISION 16 SHALL REFER TO ARCHITECTURAL & MECHANICAL DRAWINGS FOR ALL SCOPE OF WORK OF DIVISION 16 WHICH ARE RELATED TO OTHER TRADES.
- PROVIDE EACH ITEM MENTIONED OR INDICATED OF QUALITY AND SUBJECT TO QUALIFICATIONS NOTED; PERFORM ACCORDING TO CONDITIONS STATED EACH OPERATIONS STATED, EACH OPERATION PRESCRIBED; AND PROVIDE THEREFORE ALL LABOR, MATERIAL, EQUIPMENT, INCIDENTALS AND SERVICES REQUIRED TO COMPLETE THE INSTALLATION.
- 3. SCHEDULE AND COORDINATE ALL WORK WITH OTHER TRADES.
- 4. CONTRACTOR SHALL BALANCE CIRCUIT LOADS AS CLOSELY AS POSSIBLE.
- 5. REFER TO MECHANICAL DRAWINGS AND COORDINATE WITH MECHANICAL CONTRACTOR FOR EXACT LOCATION OF EQUIPMENT & DEVICES PRIOR TO ROUGH IN.
- 6. DIVISION 16 TO PROVIDE CONDUIT & WIRING FOR ALL RELOCATED ELECTRICAL & MECHANICAL EQUIPMENT FOR A COMPLETE OPERATIONAL SYSTEM.
- 7. VERIFY ON SITE FOR EXACT LOCATION OF MECHANICAL EQUIPMENT PRIOR TO ROUGH-IN.
- 8. PROVIDE BLANK COVER PLATES WHERE OUTLETS ARE REMOVED FROM EXISTING WALLS TO REMAIN
- ALL ELECTRICAL INSTALLATIONS SHALL BE RECESSED/CONCEALED INSTALLATIONS WHEREVER POSSIBLE; OTHERWISE PROVIDE WIREWOLD STEEL SURFACE MOUNTED RACEWAY (WIREMOLD 500 SERIES DEDICATED FOR EACH OUTLET) C/W SURFACE MOUNTED OUTLETS. CO-ORDINATE WITH CONSULTANTS PRIOR TO INSTALLATION.
- MODIFY/EXTEND/REPLACE EXISTING CONDUITS/WIRING/BACKBOXES AS REQUIRED FOR THE 10. RELOCATED AND EXISTING TO REMAIN EQUIPMENT/DEVICES FOR FULLY OPERATIONAL
- 11. IN CASE OF NON-ACCESSIBLE CEILING, ALL WIRING UP TO ELECTRICAL DEVICES SHALL BE DONE IN CONDUITS TO SUIT APPLICATION TO FACILITATE MAINTENANCE. PROVIDE CONDUITS AND BACK BOXES FOR LIGHTING CONTROL DEVICES TO SUIT APPLICATIONS AND AS PER MANUFACTURER'S RECOMMENDATIONS
- 12. ALL LIGHTING CONTROL WIRING IN CASE OF CAT CABLING SYSTEM, SHALL BE PROVIDED IN CONDUITS EXCEPT FOR T-BAR CEILINGS APPLICATIONS WHERE FT8 CABLES (PLENUM RATED) SHALL BE PROVIDED.
- 13. PROVIDE CONDUITS AND ENLARGED SIZED JUNCTION BOX C/W COVER PLATE FOR LIGHTING CONTROL DEVICES TO SUIT APPLICATIONS AND AS PER MANUFACTURER'S RECOMMENDATIONS.
- 14. PROVIDE FIRE STOPPING AROUND CONDUITS AND CABLES WHEN PASSING THROUGH FIRE RATED WALLS OR
- 15. COORDINATE ON SITE FOR EXACT LOCATION & MOUNTING HEIGHT OF RECEPTACLES FOR MICROWAVES AND MILLWORK APPLIANCES PRIOR TO ROUGH—IN.

CONSULTANT REVISIONS ΝП **REMARKS** DATE 01 PROGRESS DRAWING AUG. 16/23 02 ISSUED FOR PERMIT OCT. 11/23 7405 East Danbro Crescent, Mississauga, Ontario, L5N 6P8 Canada Tel: +1 416 728-0906

**ELECTRICAL LEGENDS AND SCHEDULES** 

LOUROS DESIGN 35 TEFLEY ROAD, TORONTO M2M 1C3 Tel. (416) 399-2886

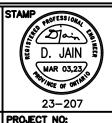

23 - 207

**PROJECT:** 

BURLINGTON SPENCER OFFICE

WATERFONT CENTRE


2023/03/03 SCALE: AS SHOWN

DRAWN/CHECKED BY:

DK DRAWING NO.

E100

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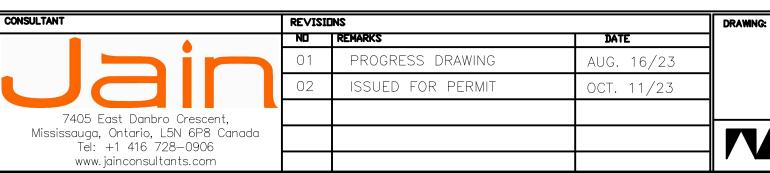


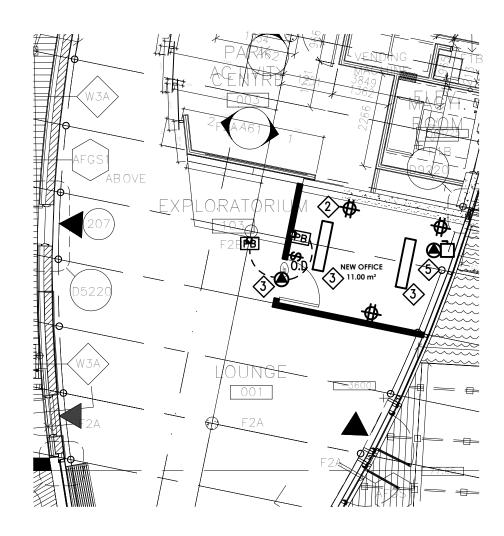GROUND FLOOR PLAN

1/8" = 1'-0"


# DRAWING NOTES:

- ALL EXISTING LIGHTING, EXITS AND EMERGENCY LIGHTING TO REMAIN, NOT SHOWN AND ARE ASSUMED TO BE IN COMPLIANCE WITH CODE.
- NEW DEVICES TO BE WIRED TO EXISTING LOCAL PANEL, UTILIZE AVAILABLE CIRCUITS AND UPDATE PANEL DIRECTORY
- PROVIDE ROUGH IN FOR BARRIER FREE DOOR OPERATOR, INCLUDING BOXES FOR BUTTONS AND 120V POWER FOR DOOR OPERATOR.
- NEW LIGHTING FIXTURE, HEWILLIAMS #MX4UD-UL8-DL15-9-35F-FAC-24 LED, LINEAR, WHITE FINISH, SUSPENDED, 0-10V DIMMING, 120V.
- 5> PROVIDE 120V POWER FOR HVAC UNIT. COORDINATE WITH MECHANICAL



ELECTRICAL PLAN

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23-207

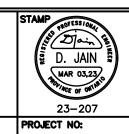PROJECT:

WATERFONT CENTRE
BURLINGTON
SPENCER OFFICE

DATE:
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SCALE:
AS SHOWN
DRAWN/CHECKED BY:
DK / RH
DRAWING NO.

E200